


KEYNOTES (#)


1. ROOF SYSTEM: TPO MEMBRANE OVER R-30 RIGID INSULATION AND PLYWOOD

- 3. STRUCTURAL FOOTING, REFER TO STRUCTURAL DRAWINGS
- 5. 4" CONCRETE SLAB ON 4" COMPACTED ABC, REFER TO FLOOR PLAN AND
- 6. STONE VENEER OVER THIN SET WITH METAL LATH WITH 3 MIL THICK VAPOR BARRIER OVER 5/8" PLYWOOD ON 2X WOOD FRAMING - RUNNING BOND COURSING - RAKE HORIZONTAL JOINTS - FLUSH VERTICAL JOINTS - STONE SEALER TO BE APPLIED ON ALL EXPOSED SURFACES - SEE ELEVATIONS FOR SPECIFICATION 7. 1" STUCCO SYSTEM OVER WOOD SHEATHING ON STUD FRAMING, REFER TO DETAIL
- 8. TPO ROOFING UP AND OVER SHEATHING AT PARAPET 9. 4" SPRAY FOAM INSULATION UNDER (3)1.5" EPS EXTRUDED POLYATRENE FOAM
- 10. STEEL CANOPY REFER TO STRUCTURAL DRAWINGS
- 11. STOREFRONT SYSTEM 1" INSULATED GLAZING, SEE WINDOW TYPES
- 15. 2x6 WOOD STUD WALL REFER TO STRUCTURAL DRAWINGS 16. GRAY CONCRETE HARDSCAPE, MEDIUM BROOM FINISH
- 18. 5/8" EXT. GRADE SAG RESISTANT GYP. BOARD AT EXTERIOR SOFFITS 19. CONTINUOUS 1/2" EXPANSION JOINT AND SEALANT - SET TOP OF JOINT 1/2" BELOW

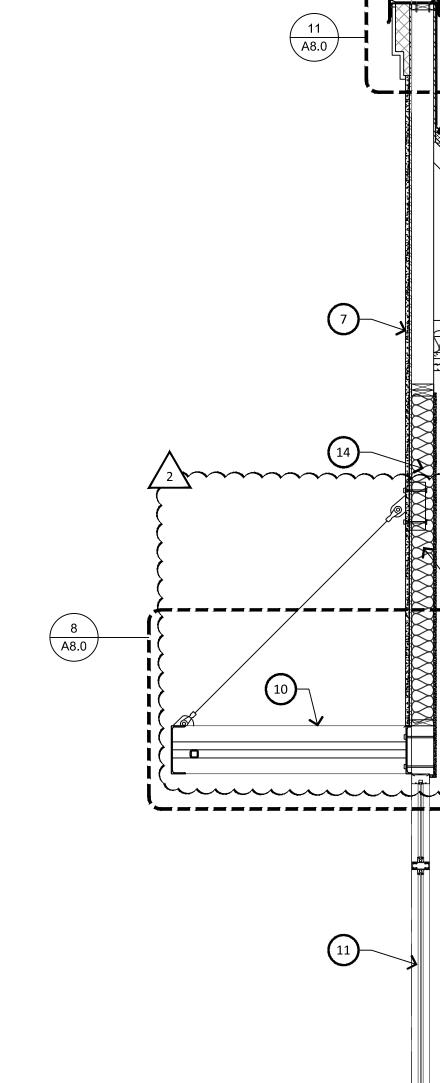


1


SCALE: 1/2" = 1'-0"

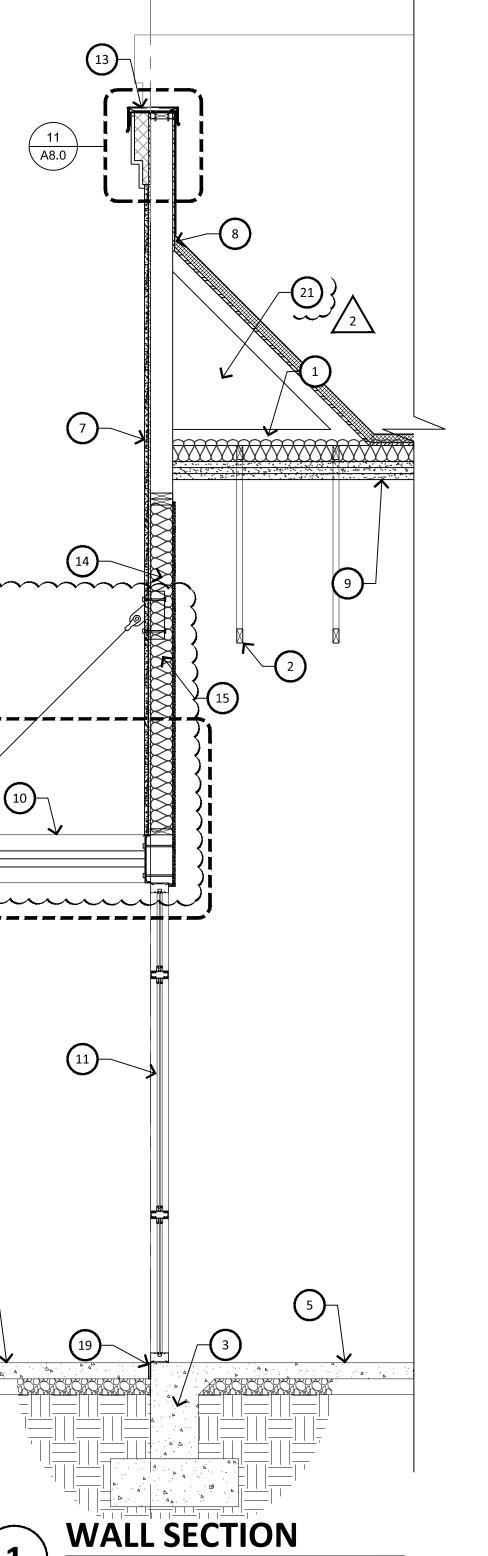





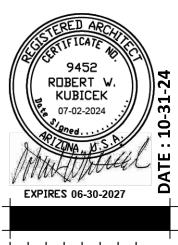

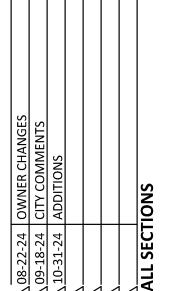



S

design by: RH drawn by: RL checked by: RH

