


REFLECTED CEILING PLAN SCALE: 1/8" = 1'-0"

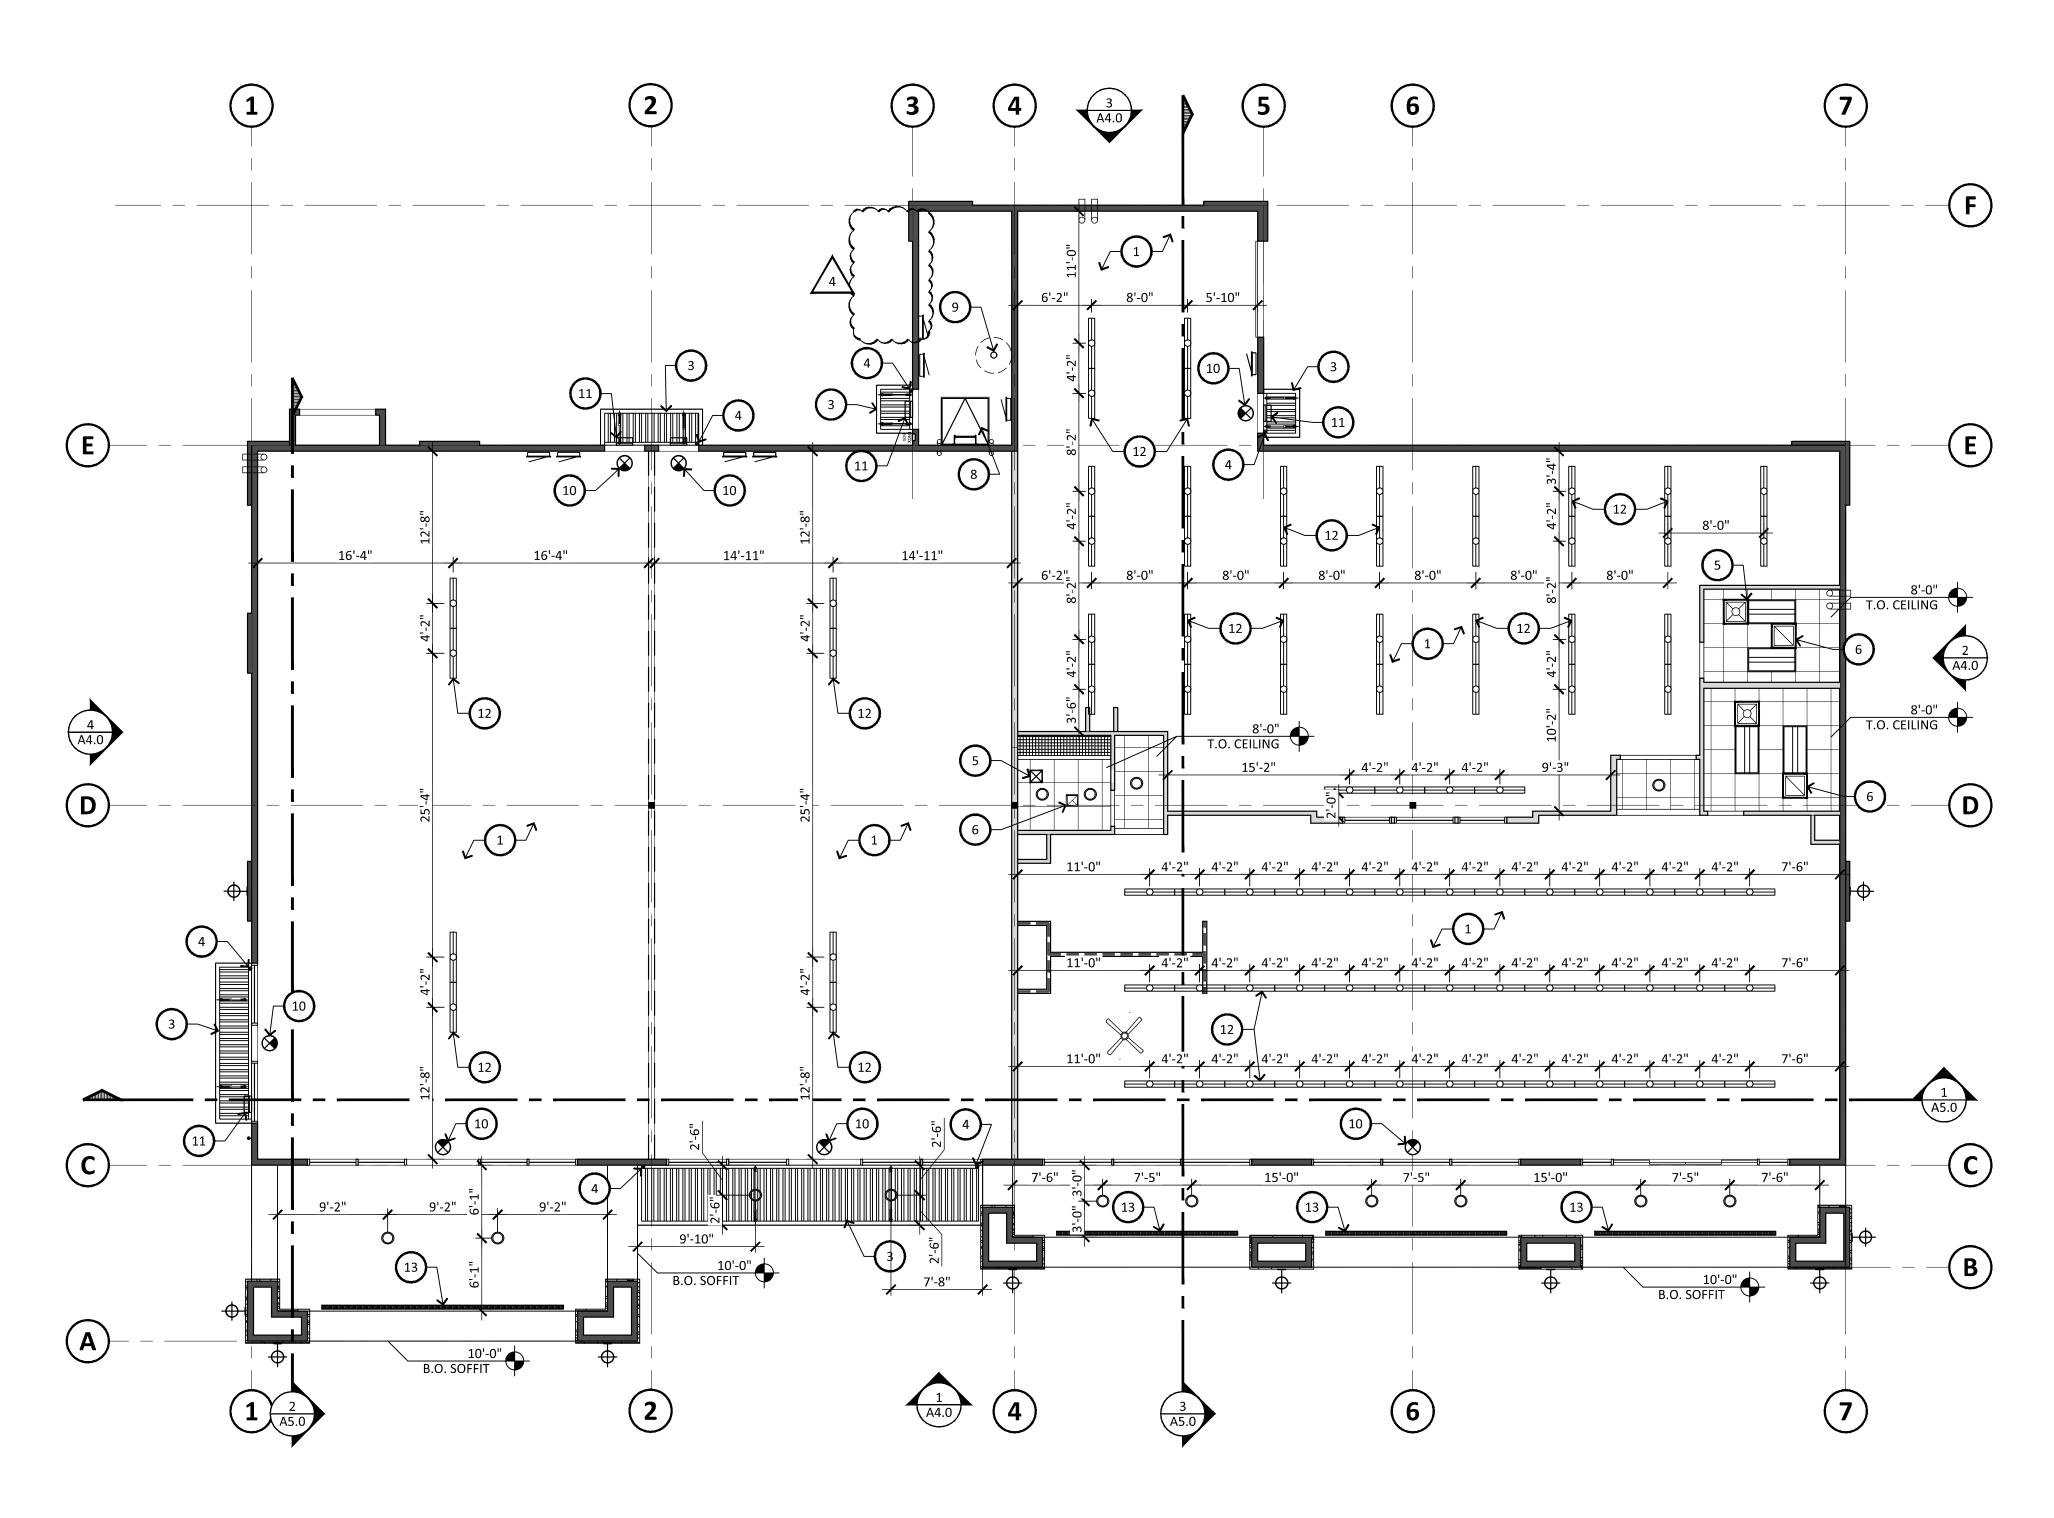



GENERAL NOTES

NOTE: PER 2012 IBC, CHAPTER 10 **1006.3 EMERGENCY POWER FOR ILLUMINATION**. THE POWER SUPPLY FOR *MEANS OF EGRESS* ILLUMINATION SHALL NORMALLY BE PROVIDED BY THE PREMISES' ELECTRICAL SUPPLY.

- IN THE EVENT OF POWER SUPPLY FAILURE, AN EMERGENCY ELECTRICAL SYSTEM SHALL AUTOMATICALLY ILLUMINATE ALL OF THE FOLLOWING AREAS: 1. AISLES AND UNENCLOSED EGRESS STAIRWAYS IN ROOMS AND SPACES THAT
- REQUIRE TWO OR MORE *MEANS OF EGRESS*.
- CORRIDORS, INTERIOR EXIT STAIRWAYS AND RAMPS AND EXIT PASSAGEWAYS IN BUILDINGS REQUIRED TO HAVE TWO OR MORE EXITS.
 EXTERIOR EGRESS COMPONENTS AT OTHER THAN THEIR LEVELS OF EXIT
- DISCHARGE UNTIL EXIT DISCHARGE IS ACCOMPLISHED FOR BUILDINGS REQUIRED TO HAVE TWO OR MORE EXITS.
 INTERIOR EXIT DISCHARGE ELEMENTS, AS PERMITTED IN SECTION 1027.1, IN
- INTERIOR EXIT DISCHARGE ELEMENTS, AS PERMITTED IN SECTION 1027.1, IN BUILDINGS REQUIRED TO HAVE TWO OR MORE EXITS.
 EXTERIOR LANDINGS AS REQUIRED BY SECTION 1008.1.6 FOR EXIT DISCURRES DOODWAYS IN DUIL DINGS REQUIRED TO HAVE TWO OR MORE
- DISCHARGE DOORWAYS IN BUILDINGS REQUIRED TO HAVE TWO OR MORE EXITS.

KEYNOTES (#)

- 1. OPEN CEILING WITH BOTTOM OF STRUCTURE
- 2. ACOUSTICAL CEILING TILES
- METAL CANOPY W/STEEL DECK ROOFING ON TUBE STEEL
 DOWNSPOUT, PRE-FINISHED METAL, DOWNSPOUT TIE INTO STORM DRAIN RE: PLUMBING DWGS
- 5. SUPPLY AIR DUCT
- 6. RETURN AIR DUCT
 7. EXHAUST FAN
- 8. ROOF HATCH & ACCESS LADDER. RE: 6/A8.0
- 9. FIRE RISER
- WALL MOUNTED EXIT SIGN, RE: ELECTRICAL DWGS
 WALL MOUNTED EXTERIOR LIGHT FIXTURE, RE: ELEVATIONS FOR MOUNTING
- HEIGHTS, SEE ELECTRICAL DWGS 12. CEILNG MOUNTED FLUORESCENT FIXTURE - MOUNTED AT +10'-0" A.F.F. -
- REFER TO ELECTRICAL DRAWINGS
- 13. 2" LINEAR VENT

LEGEND

NOTE: G.C. TO REFER TO ELECTRICAL PLANS FOR EXACT LOCATION AND TYPE.

	WALL MOUNTED EXIT LIGHT FIXTURE
ŀФ	WALL MOUNTED LIGHT FIXTURE
	FLUORESCENT LIGHT FIXTURE
\bigotimes	EXIT SIGN
\bigcirc	INTERIOR CAN LIGHT
	LED FLAT PANEL LIGHTING
\bowtie	SUPPLY AIR DUCT
	RETURN AIR DUCT
\boxtimes	RESTROOM SUPPLY AIR DUCT
	RESTROOM EXHAUST AIR DUCT
	SUSPENDED 2'x2' T-BAR GRID W/ ACOUSTICAL CEILING TILES
	GYPSUM BOARD CEILING
\varkappa	CEILING FAN





design by: RH drawn by: RL checked by: RH







